

Recording Requested By and  
When Recorded Return to:

481557

SPACE ABOVE THIS LINE FOR RECORDERS USE ONLY

**ENVIRONMENTAL COVENANT**

**THIS PROPERTY IS SUBJECT TO AN ENVIRONMENTAL COVENANT GRANTING ACCESS AND IMPOSING ACTIVITY AND USE LIMITATIONS PURSUANT TO THE UNIFORM ENVIRONMENTAL COVENANTS ACT, IDAHO CODE § 55-3001, et seq.**

This instrument is an Environmental Covenant executed by US Silver Idaho Inc. (hereinafter "Owner"), the United States Environmental Protection Agency ("EPA"), the Idaho Department of Environmental Quality ("Department") and the Successor Coeur d'Alene Custodial Work Trust (Coeur d'Alene Trust) pursuant to Idaho law including but not limited to the Uniform Environmental Covenants Act, Idaho Code §§ 55-3001 through 3015. The Department and EPA are each an "Agency" as defined in Idaho Code 55-3002(2) and are collectively referred to herein as "Agencies." This Environmental Covenant sets forth protective provisions, covenants, restrictions and conditions (collectively referred to as "Activity and Use Limitations") on the Property described below. The Activity and Use Limitations are designed to protect natural resources, human health and the environment. US Silver Idaho Inc. is also the "holder" as defined in Idaho Code § 55-3002(6). Owner/Holder, as the current property owner grants this Environmental Covenant to all signatories to this instrument.

**Property.** This Environmental Covenant concerns real property located in the County of Shoshone, State of Idaho, legally described as Parcels # C00000204375 and C00000204400 (hereafter referred to as "the Property"). The legal description of the affected portion of the property is described in the attached Exhibit "A". Owner/Holder hereby represents and warrants to the other signatories to this instrument that he/she is the sole owner of the Property as of the date this instrument is executed, holds fee simple title to the Property, and has the power and authority to enter into this instrument.

**Reason for Activity and Use Limitations.**

The implementation of the Bunker Hill Superfund Site Paved Roadways Surface Remediation Program (Roads Program) accelerated the amount of bituminous course and durable construction wastes being generated in the Basin. Since much of the Paved Roads waste volume is dominated by relatively inert concrete and asphalt pavement that has contaminated base material adhered to it, IDEQ and EPA developed a policy for safely containing materials from the Roads Program in Limited Use Repositories (LUR). Disposal at the LUR is limited to asphalt and associated road base materials and any non-contaminated fill in order to facilitate compaction and close out within three years. Paved road waste from other remedial actions is also acceptable waste for

LURs as long as it conforms to the standards provided in LUR Policy memorandum and waste acceptance criteria and design.

This instrument is necessary because the Agencies and the Coeur d'Alene Trust require access to construct a LUR on the Property. This instrument ensures Agencies and the Coeur d'Alene Trust has necessary access and requires that activities on the Property conform to the requirements herein.

**Name and Location of Administrative Record.** A copy of the administrative record for EPA decision-making at the Bunker Hill Mining and Metallurgical Complex Superfund Site (which includes the Property) can be found at the Molstead Library, North Idaho College, 1000 Garden Avenue, Coeur d'Alene, Idaho 83814 or Superfund Records Center, EPA Region 10, 1200 Sixth Avenue (Suite 900), Seattle, Washington 98101.

**Access and Activity and Use Limitations.** By acceptance and recordation of this Environmental Covenant, Owner and any successor in interest with respect to the Property, are hereby restricted from using the Property, or any portion thereof, now or at any time in the future, as specifically set forth below unless such use has been expressly approved in writing by the Agencies:

- 1. Access.** A right of access is granted to the Agencies and the Coeur d'Alene Trust, their respective contractors and third parties authorized by them for the purpose of implementing the LUR from April 20, 2015 to September 20, 2018, and thereafter as necessary to ensure continued maintenance and repair of the work over the course of the construction of the LUR.
- 2. Activity and Use Limitations.** By acceptance and recordation of this instrument, Owner, and any successors in interest with respect to the Property, are hereby restricted from using the Property, or any portion thereof, now or at any time in the future for Residential Use unless such use has been expressly approved in writing by the Agencies. All activities on the Property are subject to the Institutional Controls Program.

**Grantor's Use of the Property.** Except as provided herein, Owner reserves the right to the use and enjoyment of the Property subject to this Environmental Covenant, but such use shall not conflict or interfere with the Agencies or the Coeur d'Alene Trust's rights herein granted.

**Duration, Amendment and/or Termination by Consent.** This Environmental Covenant shall be perpetual and may only be amended or terminated pursuant to Idaho Code §§ 55-3009 and 3010. Except for an assignment undertaken pursuant to a governmental reorganization, assignment of the Environmental Covenant to a new Owner/Holder is an amendment requiring consent.

**Recording/Filing.** This Environmental Covenant, once fully executed, and any amendment or termination of the Environmental Covenant, shall be recorded for the Owner/Holder by the Coeur d'Alene Trust in the county recorder's office of every county in which any portion of the Property subject to the Easement and Environmental Covenant is located. Upon receipt of the

copy of the recorded Easement and Environmental Covenant, and any amendment or termination therein, the Department shall post the copy of the fully executed instrument in the Registry as required by Idaho Code § 55-3012(1).

**Partial Invalidity.** If any portion of this Environmental Covenant or terms set forth herein is determined to be invalid for any reason, the remaining portion shall remain in full force and effect as if such invalidated portion had not been included herein.

**No Third-Party Beneficiaries.** There are no intended third-party beneficiaries, and the parties hereto expressly disclaim any unintended third-party beneficiaries to this Environmental Covenant or any part hereof.

**Effective Date.** The effective date of this instrument shall be the date the fully executed Environmental Covenant is recorded at the county recorder's office.

**Signature and Acknowledgments**

William K. Hasz  
Owner/Holder US Silver Idaho Inc.


By: William K. Hasz

Title: General Manager

STATE OF IDAHO )  
 )  
COUNTY OF Shoshone )

On this 30<sup>th</sup> day of April, 2015, before me, a Notary Public in and for said State, personally appeared, Bill Hasz, known or identified to me to be the General Manager ~~Owner~~ and the person whose name is subscribed to the within instrument, and acknowledged to me that he/she executed the same.

In witness whereof, I have hereunto set my hand and affixed my official seal the day and year in this certificate first above written.

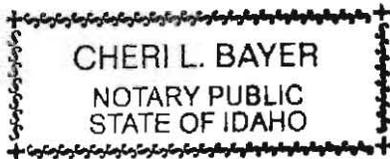

Cheri L. Bayer  
Notary Public for the State of Idaho  
Residing at: Osburn, ID  
My Commission Expires: 12/16/2020

Dated, 4/30, 2015.

481557

April 13, 2015

*CFF*


IDEQ  
By: Curt Fransen, Director

STATE OF IDAHO )  
 ) ss.  
COUNTY OF Ada )

On this 11 day of May, 2015, before me, a Notary Public in and for said State, personally appeared, Curt Fransen, known or identified to me to be the Director of the Idaho Department of Environmental Quality and whose name is subscribed to the within instrument, and acknowledged to me that he executed the same.

In witness whereof, I have hereunto set my hand and affixed my official seal the day and year in this certificate first above written.

Rosie M. Alonzo  
Notary Public for the State of Idaho  
Residing at: Nampa, ID  
My Commission Expires: 11/21/2020

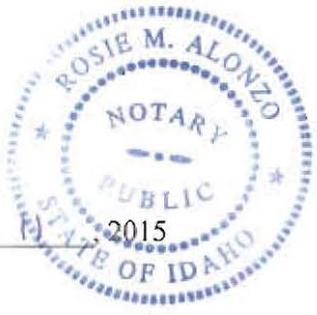

Dated, May 13, 2015

copy of the recorded Easement and Environmental Covenant, and any amendment or termination therein, the Department shall post the copy of the fully executed instrument in the Registry as required by Idaho Code § 55-3012(1).

**Partial Invalidity.** If any portion of this Environmental Covenant or terms set forth herein is determined to be invalid for any reason, the remaining portion shall remain in full force and effect as if such invalidated portion had not been included herein.

**No Third-Party Beneficiaries.** There are no intended third-party beneficiaries, and the parties hereto expressly disclaim any unintended third-party beneficiaries to this Environmental Covenant or any part hereof.

**Effective Date.** The effective date of this instrument shall be the date the fully executed Environmental Covenant is recorded at the county recorder's office.

**Signature and Acknowledgments**

William K. Hasz  
Owner/Holder US Silver Idaho Inc.


By: William K. Hasz

Title: General Manager

STATE OF IDAHO )  
COUNTY OF Shoshone )

On this 30<sup>th</sup> day of April, 2015, before me, a Notary Public in and for said State, personally appeared, Bill Hasz, known or identified to me to be the General Manager Owner and the person whose name is subscribed to the within instrument, and acknowledged to me that he/she executed the same.

In witness whereof, I have hereunto set my hand and affixed my official seal the day and year in this certificate first above written.

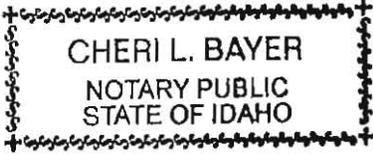

Cheri L. Bayer  
Notary Public for the State of Idaho  
Residing at: Osburn, ID  
My Commission Expires: 12/16/2020

Dated, 4/30, 2015.

481557



**TerraGraphics**  
Environmental Engineering, Inc.

www.terragraphics.com

**EXHIBIT A**  
**LEGAL DESCRIPTION**  
**FOR**

**An Environmental Covenant and Access Agreement for Construction and  
Maintenance Purposes**

All that real property being a portion of those parcels described in that deed recorded as Instrument No. 365613 with the Shoshone County Recorder, and being a portion of the Northwest Quarter (NW¼) of Section 20, Township 48 North, Range 4 East, B.M., in the City of Osburn, Shoshone County, Idaho, described as follows:

Beginning at an Idaho Transportation Department (I.T.D.) 3¼" brass-cap monument (without any engineer's stationing indicated on it) that lies at the intersection of the southwesterly right-of-way line of U.S. Interstate Highway 90 and the south right-of-way line of Nuckols Gulch Road, as shown on that I.T.D. map I-90-1(29)50, sheet 61, from which another I.T.D. 3¼" brass-cap monument (without any engineer's stationing indicated on it) on said southwesterly right-of-way line, bears North 29°16'17" West, 84.69 feet; an I.T.D. 3¼" brass-cap monument, stamped "STA 4+29.86 60 LT", on the north right-of-way line of said Nuckols Gulch Road, bears North 63°37'37" West, 442.47 feet;

1. thence along said southwesterly right-of-way line of U.S. Interstate Highway 90, South 29°16'17" East (shown as South 29°15'33" East on said I.T.D. map), 720.00 feet;
2. thence leaving said southwesterly right-of-way line, South 51°16'33" West, 77.91 feet to the northeasterly right-of-way line of Silver Valley Road (old Highway 10);
3. thence along said northeasterly right-of-way line, North 48°32'57" West (shown as North 48°31'56" West on said I.T.D. map), 840.00 feet;
4. thence leaving said northeasterly right-of-way line, North 72°50'13" East, 80.64 feet;
5. thence North 01°27'36" West, 113.23 feet to said south right-of-way line of Nuckols Gulch Road, and the beginning of a non-tangent 632.96-foot radius curve to the left;
6. thence easterly along said curve, through a central angle of 11°34'14", an arc length of 127.82 feet (the chord bears South 83°28'54" East, 127.61 feet);
7. thence South 89°16'02" East, 137.41 feet (shown as South 89°15'35" East, 137.60 feet on said I.T.D. map) to the **Point of Beginning**.

Contains 172,887 square feet (3.969 acres), more or less.

Bearings shown are grid bearings based on the Idaho State Plane Coordinate System (West Zone), NAD83 (1992); distances shown are ground.

Principal  
108 West Idaho Avenue  
Kellogg, Idaho 83837  
(208) 786-1206  
(208) 786-1209 (fax)

Offices also in:  
Boise, ID  
Helena, MT  
Deer Lodge, MT  
Las Vegas, NV

Corporate  
121 South Jackson Street  
Moscow, Idaho 83843  
208-882-7858  
208-883-3785 (fax)



481557

(Affects Tax Lots C00000204375 and C00000204400)



*Kenneth Fisher*

---

Kenneth Fisher, P.L.S.



*4/23/15*

---

Date

481557

# NUCKOLS GULCH ROAD

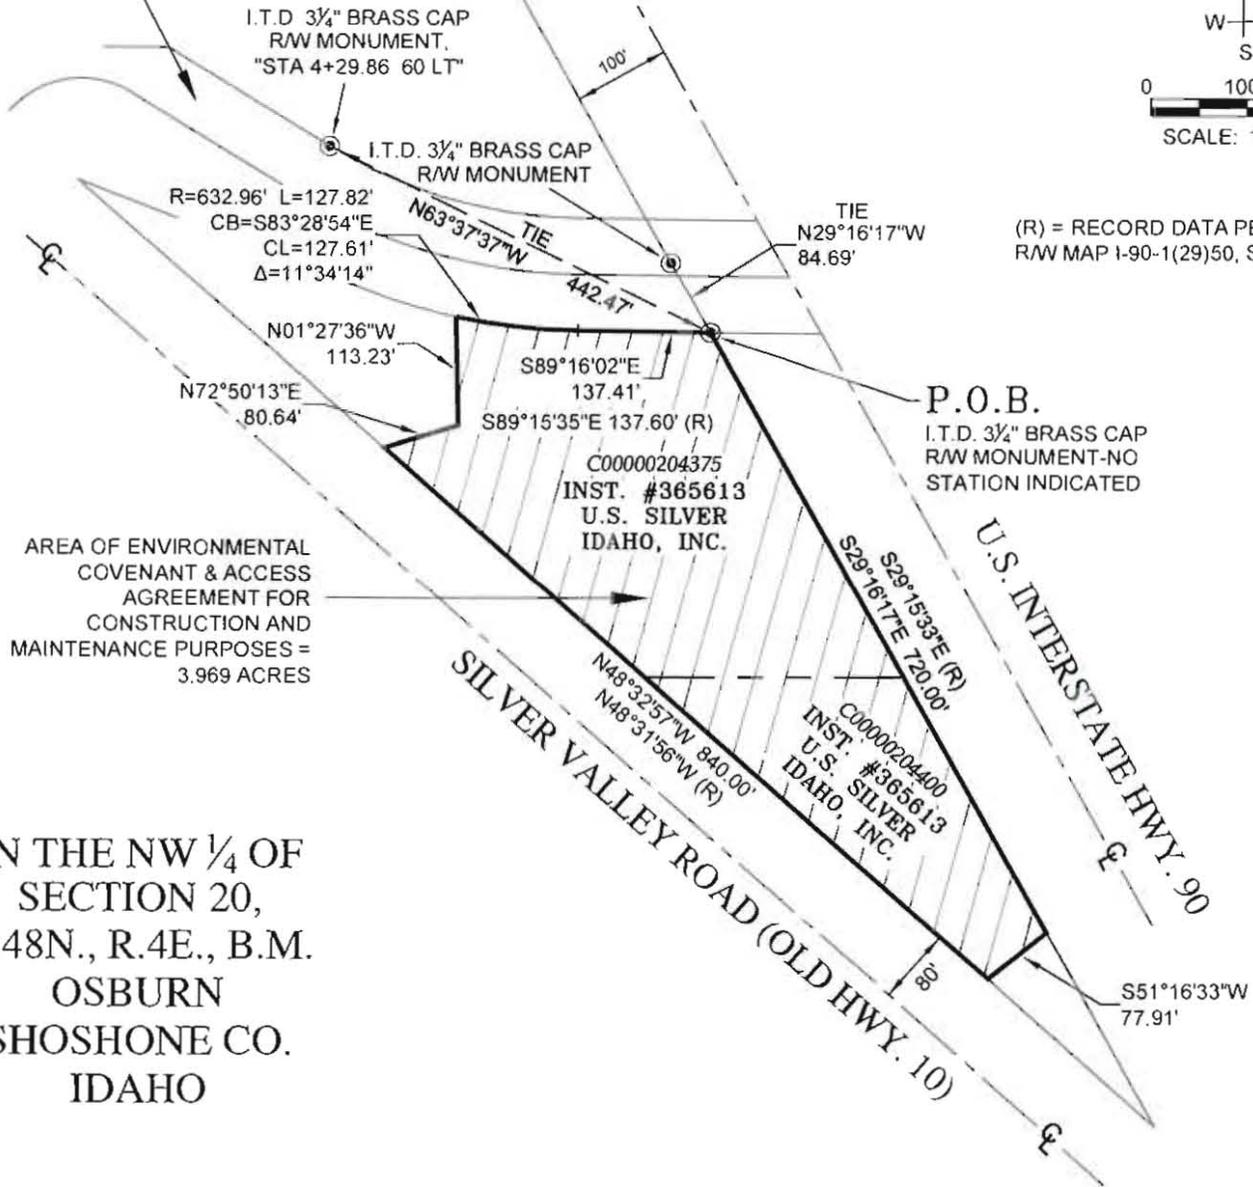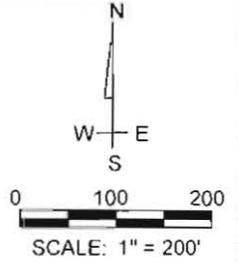

(R) = RECORD DATA PER I.T.D. R/W MAP 1-90-1(29)50, SHEET 61

AREA OF ENVIRONMENTAL COVENANT & ACCESS AGREEMENT FOR CONSTRUCTION AND MAINTENANCE PURPOSES = 3.969 ACRES

IN THE NW 1/4 OF SECTION 20, T.48N., R.4E., B.M. OSBURN SHOSHONE CO. IDAHO

### NOTES

THIS EXHIBIT SHOWS THE LOCATION OF AN ENVIRONMENTAL COVENANT & ACCESS AGREEMENT TO THE E.P.A. AND I.D.E.Q. FOR CONSTRUCTION AND MAINTENANCE PURPOSES OF THE OSBURN LIMITED-USE REPOSITORY. THE RIGHT-OF-WAY CONFIGURATIONS ARE BASED UPON DEEDS AND I.T.D. MAPS, AND ARE SHOWN FOR REFERENCE ONLY. GRID BEARINGS SHOWN ARE BASED ON IDAHO SPC, WEST ZONE, NAD83 (1992); DISTANCES SHOWN ARE GROUND.



DRAWN BY:	KF
PROJECT NO.:	15045-04
DATE:	4/23/2015

EXHIBIT B  
ENVIRONMENTAL COVENANT & ACCESS AGREEMENT FOR CONSTRUCTION AND MAINTENANCE PURPOSES

# OSBURN LIMITED USE REPOSITORY

## FINAL DESIGN

### SHOSHONE COUNTY, IDAHO

### APRIL 2015

**PROJECT SPONSORS:**

**COEUR D'ALENE TRUST**  
1174 BIG CREEK ROAD  
KELLOGG, IDAHO 83837




**USEPA Region 10**  
1209 8TH AVENUE  
MS ECL 413  
SEATTLE, WASHINGTON 98101



**ENGINEER:**

**TerraGraphics Environmental  
Engineering, Inc.**  
100 W. IDAHO AVENUE  
KELLOGG, IDAHO 83837  
TELEPHONE: (208) 795-1206

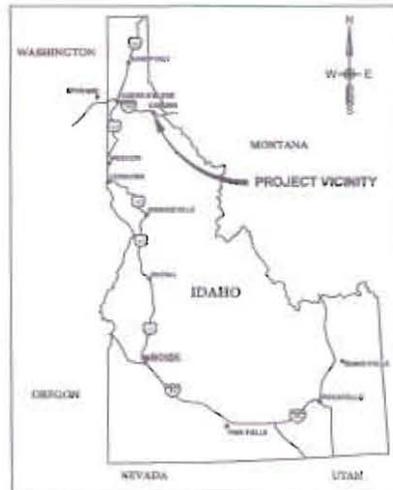

**VICINITY MAP**  
SCALE: NTS



**LOCATION MAP**  
SCALE: 1" = 500'

**SHEET INDEX**

SHEET #	SHEET NAME	SHEET INDEX
1	COVER SHEET	CS
2	GENERAL NOTES	G1
3	LEGEND, SYMBOLS, AND ABBREVIATIONS	G2
4	EXISTING SITE AND UTILITIES	C1
5	LUR LAYOUT AND WORK LIMITS	C2
6	SITE PREPARATION AND TRAFFIC CONTROL PLAN	C3
7	EROSION AND SEDIMENT CONTROL PLAN	C4
8	COVER AND SITE RESTORATION PLAN	C5
9	DETAILS	D1



NO.	DATE	REVISIONS	BY	CHK	DATE

DRAWN BY:	B. DAVIS	COORDINATE SYSTEM:	SP. 840 55 125 FT. WEST
ENGINEER:	D. FORSETH	SCALE:	AS NOTED
CHECKED:	A. HEITMANN	APPROVED:	D. FORSETH
DATE:	4/17/2015	DATE:	4/17/2015



OSBURN  
LIMITED USE  
REPOSITORY

COVER SHEET

SHEET NAME	CS
DATE	4/17/2015
PROJECT NO.	15045
SHEET	1 OF 9

481557

**WASTE ACCEPTANCE CRITERIA**

1. MATERIALS ACCEPTED SHALL BE IN COMPLIANCE WITH THE BUNKER HILL WASTE ACCEPTANCE CRITERIA SET FORTH BY OGD AND EPA (APRIL 2013) AND INCLUDE THE FOLLOWING ADDITIONS:
2. MATERIALS ACCEPTED SHALL BE ROAD WASTE MATERIAL WITH INCIDENTAL (TO A DEPTH LESS THAN 12 INCHES) SUB BASE SOILS, SANDS OR GRAVELS EXCAVATED SOLELY FROM THE PAVED ROADS PROGRAM INCLUDING:
  - 2.1. SOIL CONTAMINATED BY HEAVY METALS FROM MINE WASTE
  - 2.2. NATURAL ROCK <= 24 INCHES, IN ANY ONE DIMENSION, THAT IS IN CONTACT WITH OR CONTAINS COC\*
  - 2.3. CONCRETE, ASPHALT AND ROAD BASE <= 24 INCHES, IN ANY ONE DIMENSION, THAT CONTAINS COC\*
  - 2.4. CONCRETE, ASPHALT, BRICK OR CINDER BLOCK MATERIALS <= 12 INCHES THICK WHEN LAID FLAT ON THE GROUND AND <= 24 INCHES IN ANY OTHER DIMENSION
3. MATERIALS NOT ACCEPTED INCLUDE:
  - 3.1. IOP WASTES
  - 3.2. MATERIALS OVER 20,000 PPM LEAD
  - 3.3. PRINCIPAL THREAT MATERIALS (PTM)
  - 3.4. PETROLEUM CONTAMINATED SOILS (PCS)
  - 3.5. BUILDING DEMOLITION OR REMODELING WASTE INCLUDING CARPETING, INSULATION, SIDING, SHINGLES, PIPES AND OTHER SOLID WASTES
  - 3.6. WOOD OR ORGANIC WASTES
  - 3.7. METAL WASTES INCLUDING REBAR, PIPES, CULVERTS, METAL BRIDGEWORKS
  - 3.8. PUTRIFIABLE SOLID WASTES AND TRASH
  - 3.9. LIQUID WASTES INCLUDING STREET SWEEPING FOR SEWER CLEANOUT

**WASTE PLACEMENT AND COMPACTION**

1. WASTE MATERIAL (CONTAINING LESS THAN 5% ROCK LARGER THAN 12 INCHES) SHALL BE PLACED IN 12-INCH THICK LOOSE LIFTS.
2. WASTE MATERIAL (CONTAINING MORE THAN 5% ROCK LARGER THAN 12 INCHES) SHALL BE PLACED IN LOOSE LIFTS NO LARGER THAN 1.5 TIMES THE LARGEST ROCK DIAMETER, WITH NO LIFT GREATER THAN 24 INCHES.
3. EACH LAYER SHALL BE COMPACTED TO A FIRM, UNYIELDING SURFACE WITH A MINIMUM OF 3 PASSES USING A 10-TON VIBRATORY ROLLER.
4. CONTRACTOR MAY PROPOSE ALTERNATE EQUIPMENT AND COMPACTION TECHNIQUES FOR APPROVAL BY CDA TRUST AND ENGINEER. PROPOSED METHODS SHALL STILL PRODUCE A FIRM, UNYIELDING SURFACE.
5. EARTHWORK SHALL BE SUSPENDED WHEN UNSATISFACTORY RESULTS OCCUR DUE TO POOR WEATHER OR SITE CONDITIONS.
6. WASTE SHALL BE PLACED TO ALLOW POSITIVE DRAINAGE OF STORMWATER TOWARDS DESIGNATED BMP.
7. WASTE PLACEMENT AND COMPACTION TECHNIQUES SHALL BE FIELD TESTED, VERIFIED, DOCUMENTED AND APPROVED BY CDA TRUST OR ENGINEER PRIOR TO FULL OPERATIONS BEGINNING.

**GENERAL NOTES**

1. THE GENERAL NOTES AND SPECIFICATIONS ADDRESSED HEREIN ARE NOT COMPREHENSIVE TO THIS PROJECT. THE CONTRACTOR SHALL ALSO ADOPT BY THE PROJECT TECHNICAL SPECIFICATIONS IN THE CONTRACT DOCUMENTS (UNDER SEPARATE COVER).
2. BEARINGS AND ELEVATIONS ARE BASED ON GFS-RTK SURVEY NAD83 (1982 & NAD80) (GEOID00). THE GRID COORDINATES GENERATED ARE IDAHO STATE PLANE, WEST ZONE.
3. LOCATIONS OF EXISTING SITE FEATURES ARE APPROXIMATE. CONTRACTOR SHALL FIELD VERIFY THE EXACT LOCATION OF FEATURES AND ALL EXISTING UTILITIES BEFORE COMMENCING WORK. UNDERGROUND UTILITIES SHALL BE LOCATED AND MARKED PRIOR TO EXCAVATION. CALL THE ONE-CALL UTILITY LOCATE SERVICE AT 1-800-368-3086 AT LEAST TWO (2) WORKING DAYS PRIOR TO STARTING CONSTRUCTION.
4. CONTRACTOR SHALL LOCATE, PROTECT AND, IF DAMAGED OR ALTERED DURING CONSTRUCTION, REPAIR ALL ABOVEGROUND AND BELOWGROUND UTILITIES INCLUDING GAS, ELECTRIC, SEPTIC, WATER, SANITARY, STORM COMMUNICATION, SPRINKLER, IRRIGATION AND ETC.
5. CONTRACTOR SHALL PROTECT ADJACENT PROPERTIES AND RIGHTS-OF-WAY FROM DAMAGE AND DEBRIS DURING CONSTRUCTION.
6. THE CONTRACTOR SHALL BE RESPONSIBLE FOR THE PROTECTION OF ALL EXISTING MONUMENTS AND ANY OTHER SURVEY MARKERS DURING CONSTRUCTION. ALL SUCH MONUMENTS OR MARKERS DESTROYED DURING CONSTRUCTION SHALL BE REPLACED BY A PROFESSIONAL LICENSED SURVEYOR AT THE CONTRACTORS EXPENSE.
7. A COPY OF THESE APPROVED PLANS MUST BE ON THE JOB SITE WHENEVER CONSTRUCTION IS IN PROGRESS.
8. IF THE CONTRACTOR DISCOVERS ANY DISCREPANCIES BETWEEN THE CONSTRUCTION DOCUMENTS AND EXISTING CONDITIONS ENCOUNTERED, THE CONTRACTOR SHALL NOTIFY THE ENGINEER IMMEDIATELY.
9. AT ALL TIMES DURING CONSTRUCTION THE CONTRACTOR SHALL MAINTAIN ALL ENVIRONMENTAL PROTECTION DEVICES AS DETAILED IN THE SITE CONTROL PLAN AND THE EROSION CONTROL OR STORMWATER POLLUTION PREVENTION PLAN.
10. THE CONTRACTOR SHALL BE RESPONSIBLE FOR PROVIDING ADEQUATE SAFEGUARDS, SAFETY DEVICES, PROTECTIVE EQUIPMENT, FLAGGERS, AND ANY OTHER ACTION NEEDED TO PROTECT THE LIFE, HEALTH, AND SAFETY OF THE PUBLIC AND TO PROTECT PROPERTY IN CONNECTION WITH THE PERFORMANCE OF WORK COVERED BY THE CONTRACT.
11. DECONTAMINATION OF EQUIPMENT AND PERSONNEL IS REQUIRED FOR ACTIVITIES THAT INVOLVE CONTACT WITH CONTAMINATED SOIL.
12. DUST CONTROL SHALL BE PROVIDED AS NEEDED BY THE CONTRACTOR. WATER APPLICATION SHALL BE PROVIDED THROUGHOUT THE PROJECT ON ACCESS AND MAIL ROUTES, AT WORK INTERVALS WHERE WIND AND/OR DRY WEATHER CREATES AIRBORNE EMISSIONS, DURING LOADING AND STOCKPILING, AND PRIOR TO LEAVING THE PREMISES AT THE END OF EACH WORK DAY.
13. OSHA REQUIREMENTS SHALL BE MET OR EXCEEDED AT ALL TIMES. IT IS THE CONTRACTOR'S RESPONSIBILITY TO BE FAMILIAR WITH AND IMPLEMENT ALL CURRENT SAFETY REQUIREMENTS AND STANDARDS.



SHEET NAME:	G1
DATE:	8/17/2018
PROJECT NO:	1046
SHEET:	2 OF 3

GENERAL NOTES

OSBURN LIMITED USE REPOSITORY




DESIGN BY:	COORDINATOR:	DATE:
ENGINEER:	SCALE:	DATE:
DRAWN BY:	APPROVED:	DATE:
CHECKED:	APPROVED:	DATE:
DATE:	DATE:	DATE:


NO.	DATE	REVISIONS

481557

### SECTION AND DETAIL DESIGNATION

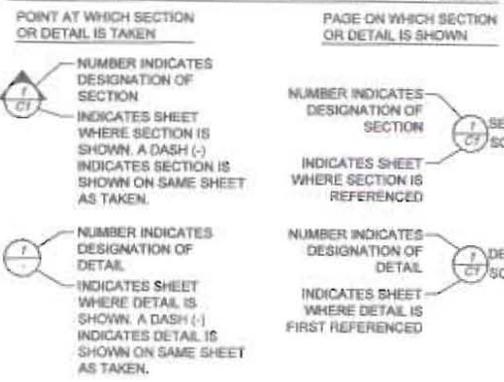

### LEGEND AND SYMBOLS

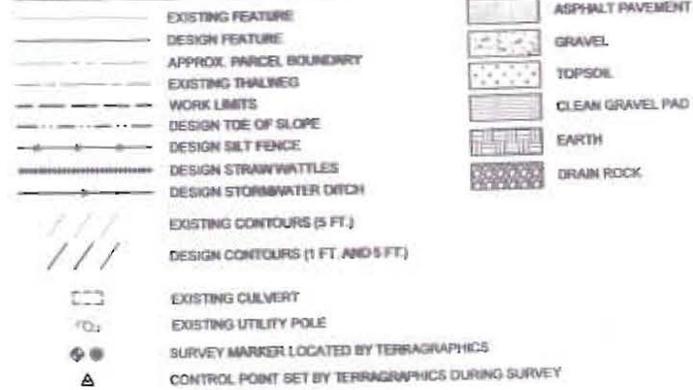

### EMERGENCY CONTACT AND UTILITY INFORMATION

<p><b>EMERGENCY</b> 911</p> <p><b>AMBULANCE NOTIFICATION</b> 14 W. MARKET AVENUE KELLOGG, ID 83837 208-784-1188</p> <p><b>AVISTA (ELEC. &amp; GAS)</b> 1-800-227-9187 LOCAL CONTACTS: GAS - DAVE MCGREGOR 208-786-6932 ELECTRIC - ALLISON SIEVERDING 208-786-6831</p> <p><b>CALL BEFORE YOU DIG</b> SHOSHONE ONE CALL 1-800-396-3285</p> <p><b>CITY OF OSBURN</b> PUBLIC WORKS CHARLIE MOONEY 208-752-0001</p>	<p><b>FRONTIER (PHONE)</b> 1-877-462-8188 LOCAL CONTACT: STEVE SMITH 208-782-4180 KEVIN STEVENS 208-818-0439 STEVE.SMITH@FRONTIER.COM</p> <p><b>POLICE</b> SHOSHONE COUNTY SHERIFF 208-556-1114</p> <p><b>PUBLIC WATER</b> CENTRAL SHOSHONE CO. WATER DISTRICT BARNEY NORRIS 208-786-8823</p> <p><b>SOUTH FORK COEUR D'ALENE RIVER SEWER DISTRICT</b> 1020 POLARIS AVENUE OSBURN, ID 83849 ROSS STOUT 208-753-8041</p> <p><b>WALLACE SCHOOL DISTRICT</b> 1 MINERS ALLEY WALLACE, ID 83873 208-753-5315</p>
--	--


### ABBREVIATIONS

APPROX.	APPROXIMATELY	ISP	IDAHO STATE PLANE
BH	BUNKER HILL	LF	LINEAR FEET
BMP	BEST MANAGEMENT PRACTICES	LUR	LIMITED USE REPOSITORY
CDA	COEUR D'ALENE	MIN	MINIMUM
CO	COUNTY	MAX	MAXIMUM
COCs	CONTAMINANTS OF CONCERN	MUTCD	MANUAL OF UNIFORM TRAFFIC CONTROL DEVICES
CP	CONTROL POINT	N	NORTHING
CU YDS	CUBIC YARDS	NAD	NORTH AMERICAN DATUM
DIA.	DIAMETER	NAVD	NORTH AMERICAN VERTICAL DATUM
E	EASTING	NO.	NUMBER
ELEC.	ELECTRIC	NTS	NOT TO SCALE
ELEV	ELEVATION	OSHA	OCCUPATIONAL SAFETY AND HEALTH ADMINISTRATION
FD	FOUND	PERF	PERFORATED
FT.	FEET	PCS	PETROLEUM CONTAMINATED SOILS
GPS	GEOGRAPHIC POSITIONING SYSTEM	PLS	PROFESSIONAL LAND SURVEYOR
I-90	INTERSTATE 90	PPM	PARTS PER MILLION
ICP	INSTITUTIONAL CONTROL PROGRAM	PTM	PRINCIPAL THREAT MATERIALS
ITD	IDAHO TRANSPORTATION DEPARTMENT	PVC	POLYVINYL CHLORIDE
ID	IDAHO	ROW	RIGHT OF WAY
IN.	INCH	STA	STATION
INC.	INCORPORATED	TYP	TYPICAL
		US	UNITED STATES
		VEG	VEGETATION
		WSE	WATER SURFACE ELEVATION



M:\CDA TRUST\15045 LUR Design and Construction\Drawings\1\_1\_Plan\OSBURN LUR\_GENERAL\_FINAL.dwg 4/17/2015

NO.	DATE	REVISIONS	BY	CHK	DRAWN BY B DAVIS	COORDINATE SYSTEM ISP, NAD 83 US FT., WEST	SCALE AS NOTED	APPROVED D FORSETH	DATE 4/17/2015		OSBURN LIMITED USE REPOSITORY	LEGEND, SYMBOLS, AND ABBREVIATIONS	SHEET NAME G2
					ENGINEER D FORSETH	APPROVED A HEITMANN	DATE 4/17/2015	DATE 4/17/2015	PROJECT NO. 15045				SHEET 2 OF 8

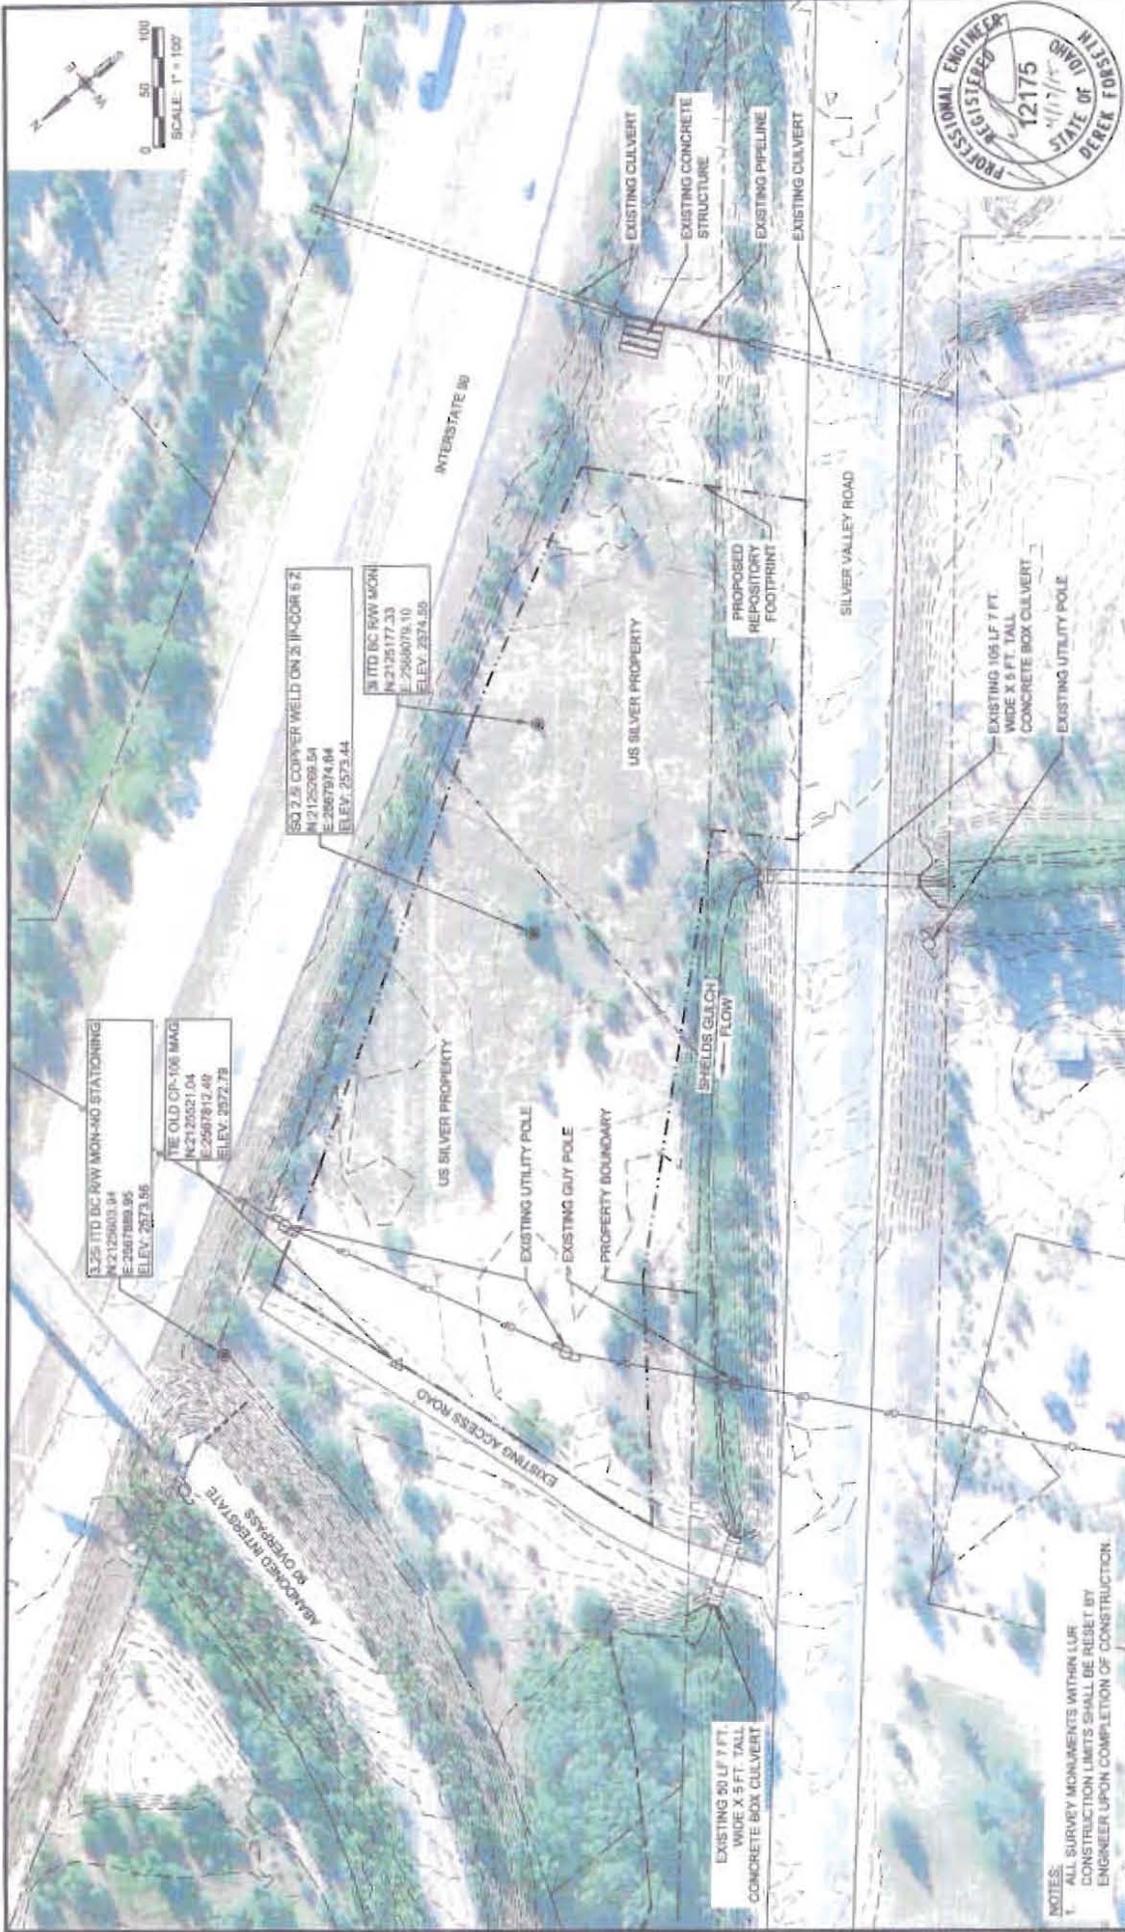

SHEET NAME	C1
DATE	4/17/2015
PROJECT NO.	OSBORN
DRAWN BY	4/17/15

EXISTING SITE AND UTILITIES

OSBORN LIMITED USE REPOSITORY




DESIGNED BY	E. DAVIS	COORDINATOR	E. DAVIS
CHECKED BY	D. FORESTH	SCALE	AS SHOWN
DATE	4/17/2015	APPROVED BY	A. HETTMANN
DATE	4/17/2015	DATE	4/17/2015

NOTES:  
 1. ALL SURVEY MONUMENTS WITHIN LLR CONSTRUCTION LIMITS SHALL BE RESET BY ENGINEER UPON COMPLETION OF CONSTRUCTION.



M:\CDA TRUST\15045 LUR Design and Construction\Drawings\3\_Files\OSB\RM\_LUR\_DESIGN\_FINAL\_041715.dwg 4/17/2015

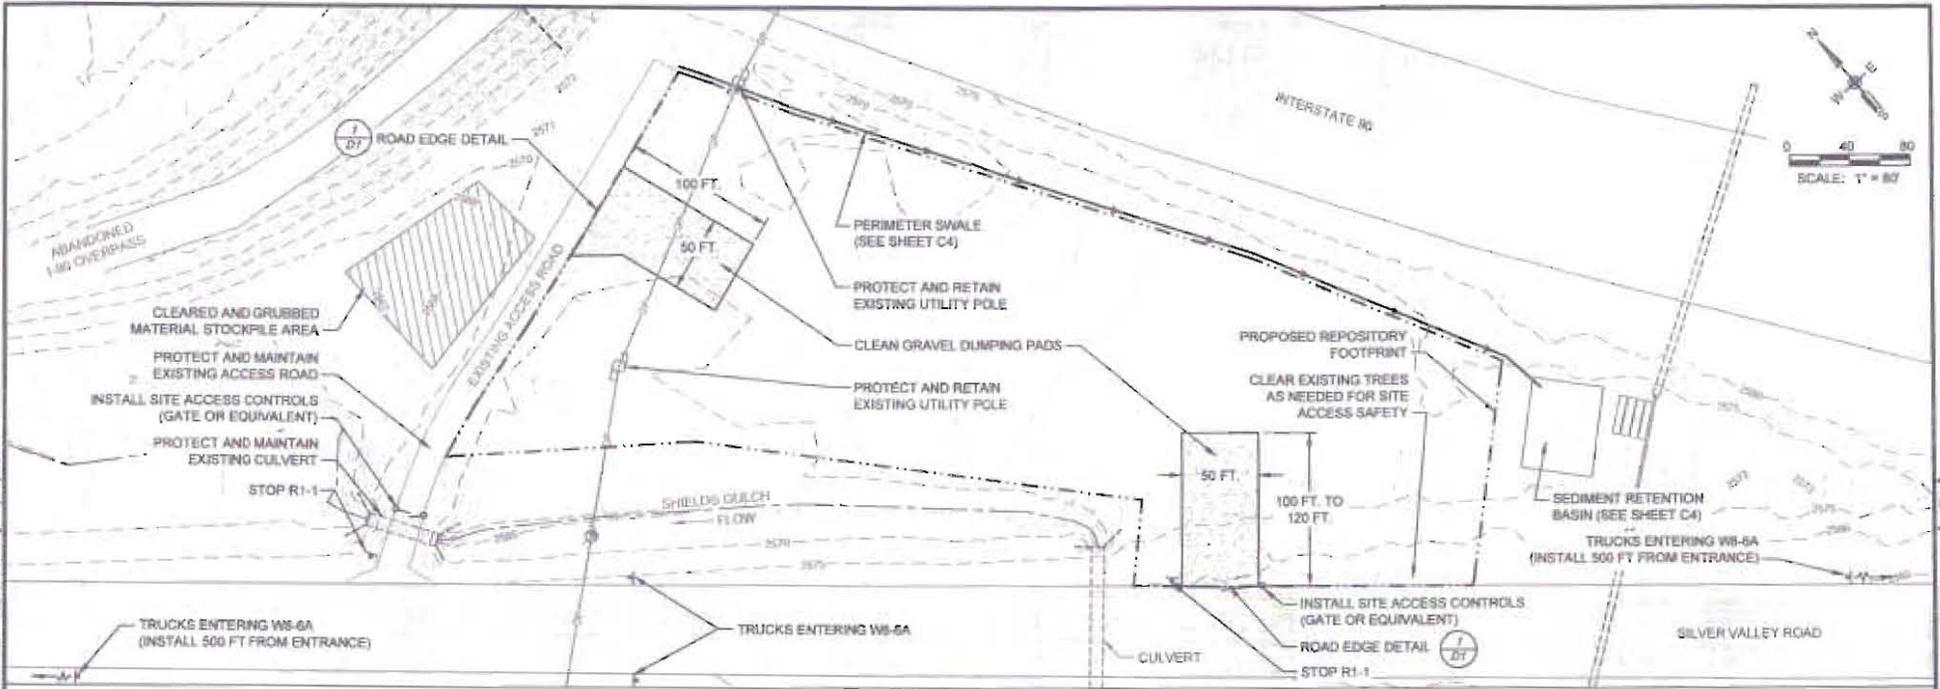

481557

**SITE PREPARATION PLAN SEQUENCE**

1. COORDINATE THE INSTALLATION OF TEMPORARY EROSION AND SEDIMENT CONTROL BMPs WITH SITE PREPARATION WORK.
2. STAKE WORK LIMITS AND ACCESS ROAD LOCATIONS.
3. INSTALL BMPs.
4. INSTALL PAVED ROAD EDGE PROTECTION.
5. INSTALL FENCING/GATES FOR ACCESS CONTROL. FIT CONTROLS IN THE FIELD TO PREVENT UNAUTHORIZED ACCESS ONTO THE SITE.
6. DEVELOP ACCESS ROAD, HAUL ROUTES, STAGING AREAS, STOCKPILE AREAS AND SIMILAR. ADJUST ALIGNMENTS AS NECESSARY TO PROVIDE SAFE ACCESS.
7. INSTALL DIRECTIONAL AND WARNING SIGNAGE. SIGNAGE SHALL BE MUTCD COMPLIANT.



NO.	DATE	REVISIONS	BY	CHK.	DATE

DRAWN BY	A. HEITMANN	COORDINATE SYSTEM	SP, NAD 83 US FT, WEST
ENGINEER	D. FORSETH	SCALE:	1" = 80'
CHECKED	A. HEITMANN	APPROVED:	D. FORSETH
DATE	4/17/2015	DATE	4/17/2015



OSBURN  
LIMITED USE  
REPOSITORY

SITE PREPARATION AND  
TRAFFIC CONTROL PLAN

SHEET NAME	C3
DATE	4/17/2015
PROJECT NO.	15045
SHEET	3 OF 8





481557

**Instrument # 481557**

WALLACE, SHOSHONE COUNTY, IDAHO

7-6-2015 02:23:00 PM No. of Pages: 17

Recorded for : TERRAGRAPHS ENVIRON ENG

PEGGY DELANGE-WHITE Fee: 58.00

Ex-Officio Recorder Deputy

Index to: ENVIRONMENTAL COVENANT

2015 JUL 6 PM 2 23

**TERRAGRAPHS  
108 WEST IDAHO  
KELLOGG, ID 83837**